

**U.S. Army Corps
of Engineers**
Pittsburgh District

Public Notice

In Reply Refer to
Notice No. below

US Army Corps of Engineers, Pittsburgh District
1000 Liberty Avenue
Pittsburgh, PA 15222-4186

Application No. 2003-1292

Date: July 18, 2013

Notice No. 13-31

Closing Date: August 17, 2013

1. TO ALL WHOM IT MAY CONCERN: The following application has been submitted for a Department of the Army Permit under the provisions of Section 10 of the Rivers and Harbors Act of 1899.
2. APPLICANT:
Ethan Russell
NRG Power Midwest LP
121 Champion Way, Suite 300
Canonsburg, Pennsylvania 15317
3. LOCATION: Monongahela River, Left Bank, Mile 25.18, in Union Township, Washington County and Jefferson Hills Borough, Allegheny County, Pennsylvania.
4. PURPOSE AND DESCRIPTION OF WORK: The applicant proposes to perform maintenance dredging, as necessary, for a period of 10 years, to maintain the Elrama Power Station docking facility in its originally permitted configuration as well as to eliminate restriction of intake by river sediments. Approximately 23,000 cubic yards of material would be dredged from an area 1,600 feet long by 150 feet wide and to a depth of 12 feet below normal pool elevation 726.9. The dredged material would be transported to an upland disposal site to preclude its reentry into the river. Drawing and Map of the proposed project are attached to this notice.
5. ENCROACHMENT PERMIT: The applicant has an active encroachment permit from the Pennsylvania Department of Environmental Protection. (S-6378727)
6. IMPACT ON NATURAL RESOURCES: The District Engineer has consulted the most recently available information and has determined that the project will have no effect on endangered species or threatened species, or result in destruction or adverse modification of habitat of such species which has been determined to be critical. While concurrence with this determination is not required, this Public Notice serves as a request to the U.S. Fish and Wildlife

Service for any additional information they may have on whether any listed or proposed to be listed endangered or threatened species may be present in the area which would be affected by the activity, pursuant to Section 7(c) of the Endangered Species Act of 1972 (as amended).

7. IMPACT ON CULTURAL RESOURCES: The National Register of Historic Places has been consulted, and it has been determined that there are no properties currently listed on the register which would be directly affected by the proposed work. If we are made aware, as a result of comments received in response to this notice, or by other means, of specific archeological, scientific, prehistorical, or historical sites or structures which might be affected by the proposed work, the District Engineer will immediately take the appropriate action necessary pursuant to the National Historic Preservation Act of 1966 - Public Law 89-665 as amended (including Public Law 96-515).

8. PUBLIC INVOLVEMENT: Any person may request, in writing, within the comment period specified in the paragraph below entitled "RESPONSES," that a public hearing be held to consider this application. The requests for public hearing shall state, with particularity, the reasons for holding a public hearing.

9. EVALUATION: Interested parties are invited to state any objections they may have to the proposed work. The decision whether to issue a permit will be based on an evaluation of the probable impact including cumulative impacts of the proposed activity on the public interest. That decision will reflect the national concern for both protection and utilization of important resources. The benefit which reasonably may be expected to accrue from the proposals must be balanced against its reasonably foreseeable detriments. All factors which may be relevant to the proposal will be considered including the cumulative effects thereof; among those are conservation, economics, aesthetics, general environmental concerns, wetlands, historic properties, fish and wildlife values, flood hazards, flood plain values, land use, navigation, shoreline erosion and accretion, recreation, water supply and conservation, water quality, energy needs, safety, food and fiber production, mineral needs, considerations of property ownership and, in general, the needs and welfare of the people. The Corps of Engineers is soliciting comments from the public; Federal, state, and local agencies and officials; Indian Tribes; and other interested parties in order to consider and evaluate the impacts of this proposed activity. Any comments received will be considered by the Corps of Engineers to determine whether to issue, modify, condition or deny a permit for this proposal. To make this decision, comments are used to assess impacts on endangered species, historic properties, water quality, general environmental effects, and the other public interest factors listed above. Comments are used in the preparation of an Environmental Assessment and/or an Environmental Impact Statement pursuant to the National Environmental Policy Act. Comments are also used to determine the overall public interest of the proposed activity.

10. RESPONSES: A permit will be granted unless its issuance is found to be contrary to the public interest. Written statements concerning the proposed activity should be received in this office on or before the closing date of this Public Notice in order to become a part of the record and to be considered in the final determination. Any objections which are received during this period may be forwarded to the applicant for possible resolution before the determination is made whether to issue or deny the requested DA Permit. All responses to this notice should be directed to the Regulatory Branch, attn Linda Everley at the above address, by telephoning (412) 395-7152, or by e-mail at Linda.L.Everley@usace.army.mil. Please refer to CELRP-OP-F 2003-1292 in all responses.


FOR THE DISTRICT ENGINEER:

/signed/

Scott A. Hans
Chief, Regulatory Branch



NORTH

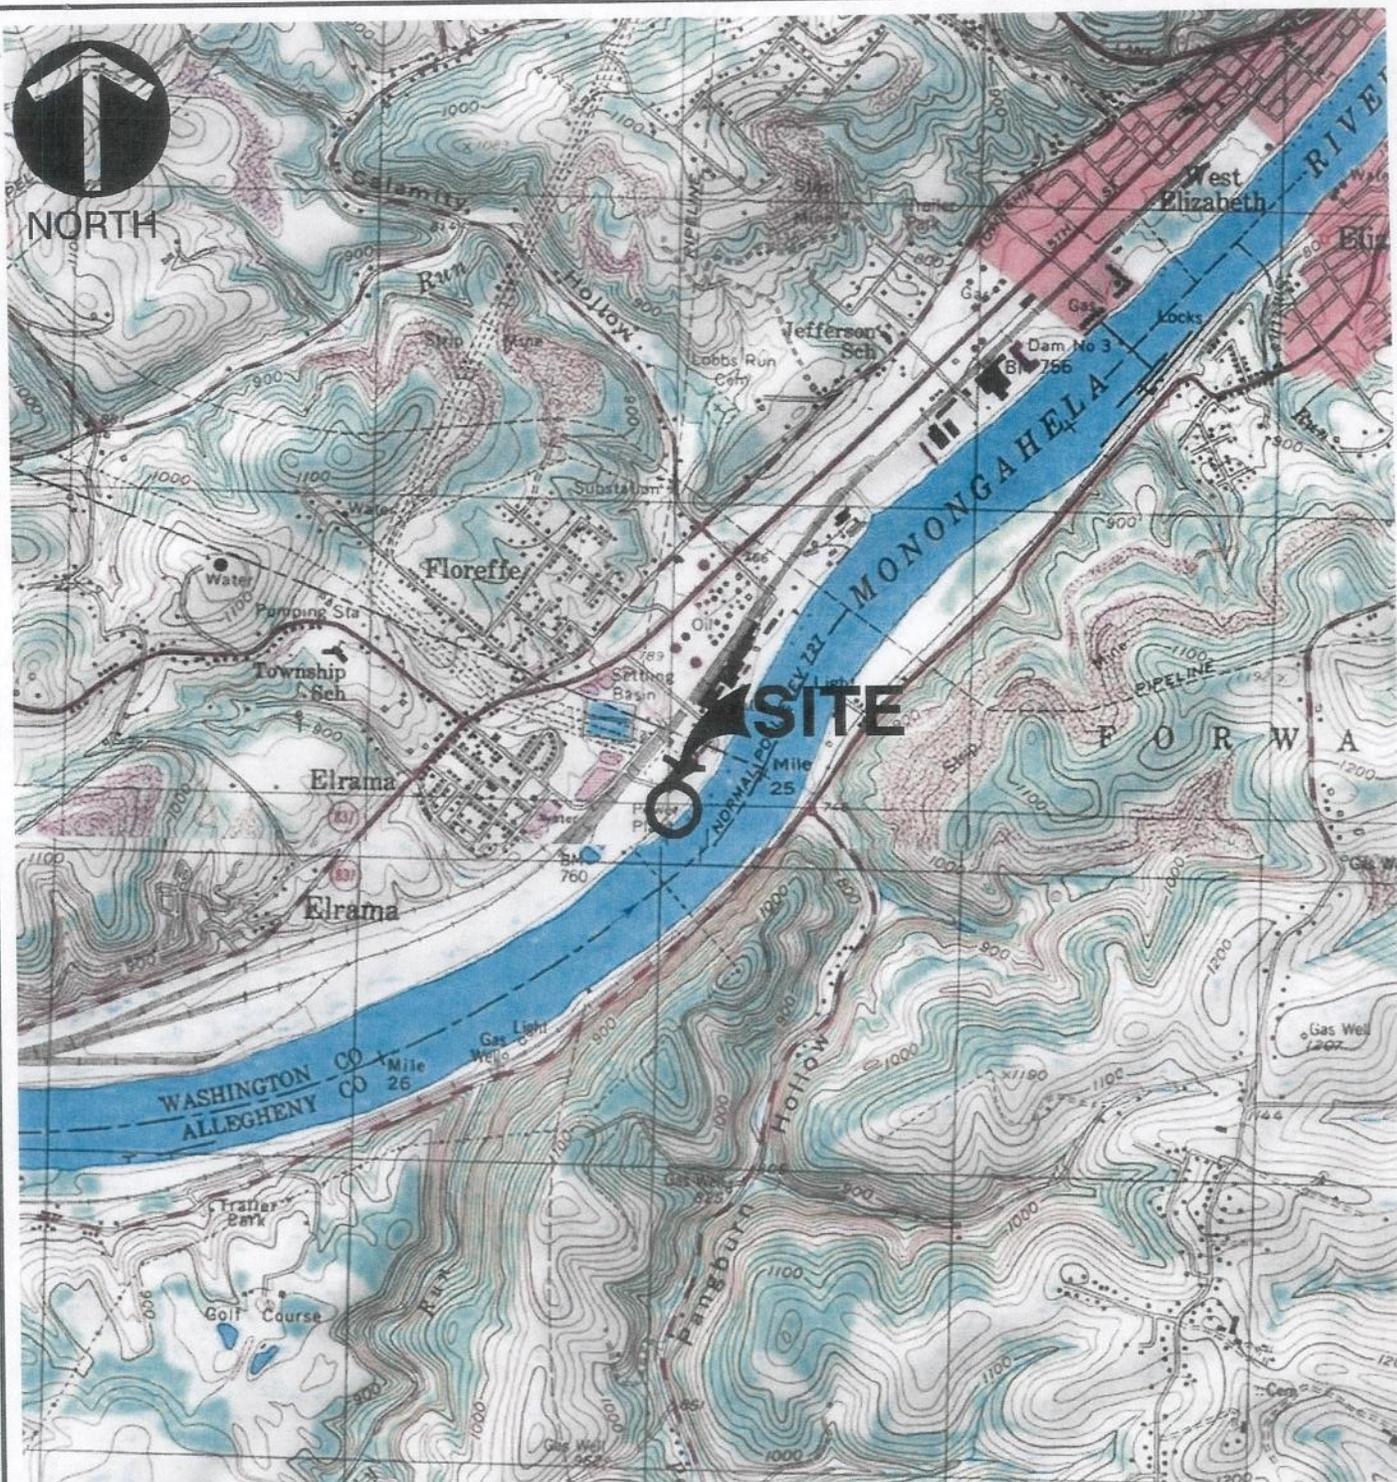


SITE

REFERENCE

USGS 7.5 MINUTE TOPOGRAPHIC MAP, GLASSPORT (1996)
AND MONONGAHELA (1996) QUADRANGLES, ARCGIS MAP
SERVICE: [HTTP://GOTO.ARCGISONLINE.COM/
MAPS/USA_TOPO_MAPS](http://goto.arcgisonline.com/maps/usa_topo_maps), ACCESSED 03/12/2013.

SCALE IN FEET

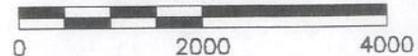

* HAND SIGNATURE ON FILE



Civil & Environmental Consultants, Inc.

333 Baldwin Road - Pittsburgh, PA 15205
412-429-2324 · 800-365-2324
www.cecinc.com

NRG Power Midwest, LP

ELRAMA POWER PLANT
UNION TWP, WASHINGTON COUNTY, AND JEFFERSON
HILLS BOROUGH, ALLEGHENY COUNTY, PENNSYLVANIA

USGS SITE LOCATION MAP

DRAWN BY:	LKC	CHECKED BY:	SMF	APPROVED BY:	*MRH	FIGURE NO.:	1
DATE:	03/12/2013	DWG SCALE:	1" = 2000'	PROJECT NO.:	130-305		

P:\12013\130-305\CADD\DWG\130305-ECO-FIG-1.DWG(ECO-FIG-1)LS:(FRAMPON - 6/10/2013) - LF: 6/10/2013 4:29:53 PM



NOTE: PROPOSED DREDGING TO 12' BELOW NORMAL POOL ELEVATION OF 726.9 FEET MEAN SEA LEVEL (MSL). APPROXIMATELY 23,000 CU. YDS OF MATERIAL TO BE DREDGED.



LEGEND
 DREDGING AREA (5.5 ACRES)

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 333 Baldwin Road - Pittsburgh, PA 15205-9072
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NRG Power Midwest, LP
 ELRAMA POWER PLANT
 UNION TWP, WASHINGTON COUNTY, AND JEFFERSON HILLS BOROUGH, ALLEGHENY COUNTY, PENNSYLVANIA

REFERENCE
 ESRI WORLD IMAGERY / ARCGIS MAP SERVICE:
[HTTP://GTO.ARCGISONLINE.COM/IMAPS/](http://gto.arcgis.com/IMAPS/)
 WORLD IMAGERY.
 ACCESSED 6/10/2013. IMAGERY DATE: 2011.

PROPOSED MAINTENANCE DREDGING MAP

DRAWN BY:	MSM	CHECKED BY:	SMF
DATE:	6/10/2013	SCALE:	1" = 250'
APPROVED BY:	* Hand signature MRH* on file		FIGURE NO:
PROJECT NO:	130-305		2