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# Public Notice

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**U.S. Army Corps  
of Engineers**  
Pittsburgh District

In Reply Refer to  
Notice No. below

US Army Corps of Engineers, Pittsburgh District  
1000 Liberty Avenue  
Pittsburgh, PA 15222-4186

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Application No. LRP-2005-003

Date: 3-FEB-2015

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Notice No. 15-5

Closing Date: 24-FEB-2015

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1. **TO ALL WHOM IT MAY CONCERN:** The following application has been submitted for a Department of the Army Permit under the provisions of Section 404 of the Clean Water Act.
  
2. **APPLICANT:**  
  
Conemaugh Township  
Attn: Mr. Steven Buncich  
1120 Tire Hill Rd.  
Johnstown, PA 15905
  
3. **LOCATION:** within Stonycreek River at Greenhouse Park, south of Johnstown, Somerset County, PA (40.277853°N, -78.923289° W)
  
4. **PURPOSE AND DESCRIPTION OF WORK:** The applicant proposes to construct Phase II of the Stonycreek Whitewater Park Project for the purposes of enhancing the downstream portion and functionality of the existing structures that were completed in Phase I. The proposed project scope includes cobble bar excavation and installation of a weir (approximately 1,025 linear feet in length), which will improve the functionality of the whitewater course. During Phase I 1,500 linear feet of stream bank protection, two drop structures, and two diversions were constructed. Since its construction, thousands of boaters have utilized the course to enjoy whitewater sports and to improve their skills. The proposed Phase II project will improve the conditions of the existing park by lowering the water surface elevation downstream of the existing course. The most downstream drop structure, which is currently submerged, is not functioning as intended. Lowering the downstream water surface elevation will achieve the target hydraulic conditions at the lowest drop structure. The proposed weir will be placed in the excavated area downstream and will be used to have greater control of the water surface height and reduce the frequency of the maintenance for the park. The Phase II Project will allow for boaters to re-gain full use of the water park upon completion.
  
5. **ENCROACHMENT PERMIT:** The applicant must obtain a Water Obstruction and Encroachment Permit which includes 401 Water Quality Certification from the:

Pennsylvania Department of Environmental Protection  
Southwest Regional Office  
Waterways and Wetlands Section  
400 Waterfront Drive  
Pittsburgh, PA 15222-4745

Telephone: 412-442-4000

6. IMPACT ON NATURAL RESOURCES: The District Engineer has consulted the most recently available information and has determined that the project will have no effect on endangered species or threatened species, or result in destruction or adverse modification of habitat of such species which has been determined to be critical. While concurrence with this determination is not required, this Public Notice serves as a request to the U.S. Fish and Wildlife Service for any additional information they may have on whether any listed or proposed to be listed endangered or threatened species may be present in the area which would be affected by the activity, pursuant to Section 7(c) of the Endangered Species Act of 1972 (as amended).

7. IMPACT ON CULTURAL RESOURCES: The National Register of Historic Places has been consulted, and it has been determined that there are no properties currently listed on the register which would be directly affected by the proposed work. If we are made aware, as a result of comments received in response to this notice, or by other means, of specific archeological, scientific, prehistorical, or historical sites or structures which might be affected by the proposed work, the District Engineer will immediately take the appropriate action necessary pursuant to the National Historic Preservation Act of 1966 - Public Law 89-665 as amended (including Public Law 96-515).

8. PUBLIC INVOLVEMENT: Any person may request, in writing, within the comment period specified in the paragraph below entitled "RESPONSES," that a public hearing be held to consider this application. The requests for public hearing shall state, with particularity, the reasons for holding a public hearing.

9. EVALUATION: Interested parties are invited to state any objections they may have to the proposed work. The decision whether to issue a permit will be based on an evaluation of the probable impact including cumulative impacts of the proposed activity on the public interest. That decision will reflect the national concern for both protection and utilization of important resources. The benefit which reasonably may be expected to accrue from the proposals must be balanced against its reasonably foreseeable detriments. All factors which may be relevant to the proposal will be considered including the cumulative effects thereof; among those are conservation, economics, aesthetics, general environmental concerns, wetlands, historic properties, fish and wildlife values, flood hazards, flood plain values, land use, navigation, shoreline erosion and accretion, recreation, water supply and conservation, water quality, energy needs, safety, food and fiber production, mineral needs, considerations of property ownership and, in general, the needs and welfare of the people. The Corps of Engineers is soliciting comments from the public; Federal, state, and local agencies and officials; Indian Tribes; and


other interested parties in order to consider and evaluate the impacts of this proposed activity. Any comments received will be considered by the Corps of Engineers to determine whether to issue, modify, condition or deny a permit for this proposal. To make this decision, comments are used to assess impacts on endangered species, historic properties, water quality, general environmental effects, and the other public interest factors listed above. Comments are used in the preparation of an Environmental Assessment and/or an Environmental Impact Statement pursuant to the National Environmental Policy Act. Comments are also used to determine the overall public interest of the proposed activity. The evaluation of the impact of the activity on the public interest will include application of the guidelines promulgated by the Administrator, Environmental Protection Agency, under the authority of Section 404(b) of the Clean Water Act (40 CFR Part 230).

10. RESPONSES: A permit will be granted unless its issuance is found to be contrary to the public interest. Written statements concerning the proposed activity should be received in this office on or before the closing date of this Public Notice in order to become a part of the record and to be considered in the final determination. Any objections which are received during this period may be forwarded to the applicant for possible resolution before the determination is made whether to issue or deny the requested DA Permit. All responses to this notice should be directed to the Regulatory Branch, attn Josh Shaffer at the above address, by telephoning (412) 395-7121, or by e-mail at [Joshua.d.shaffer@usace.army.mil](mailto:Joshua.d.shaffer@usace.army.mil). Please refer to CELRP-OP-F 2005-003 in all responses.

FOR THE DISTRICT ENGINEER:

// SIGNED //


Karen A. Kochenbach  
Chief, Southern Section  
Regulatory Branch

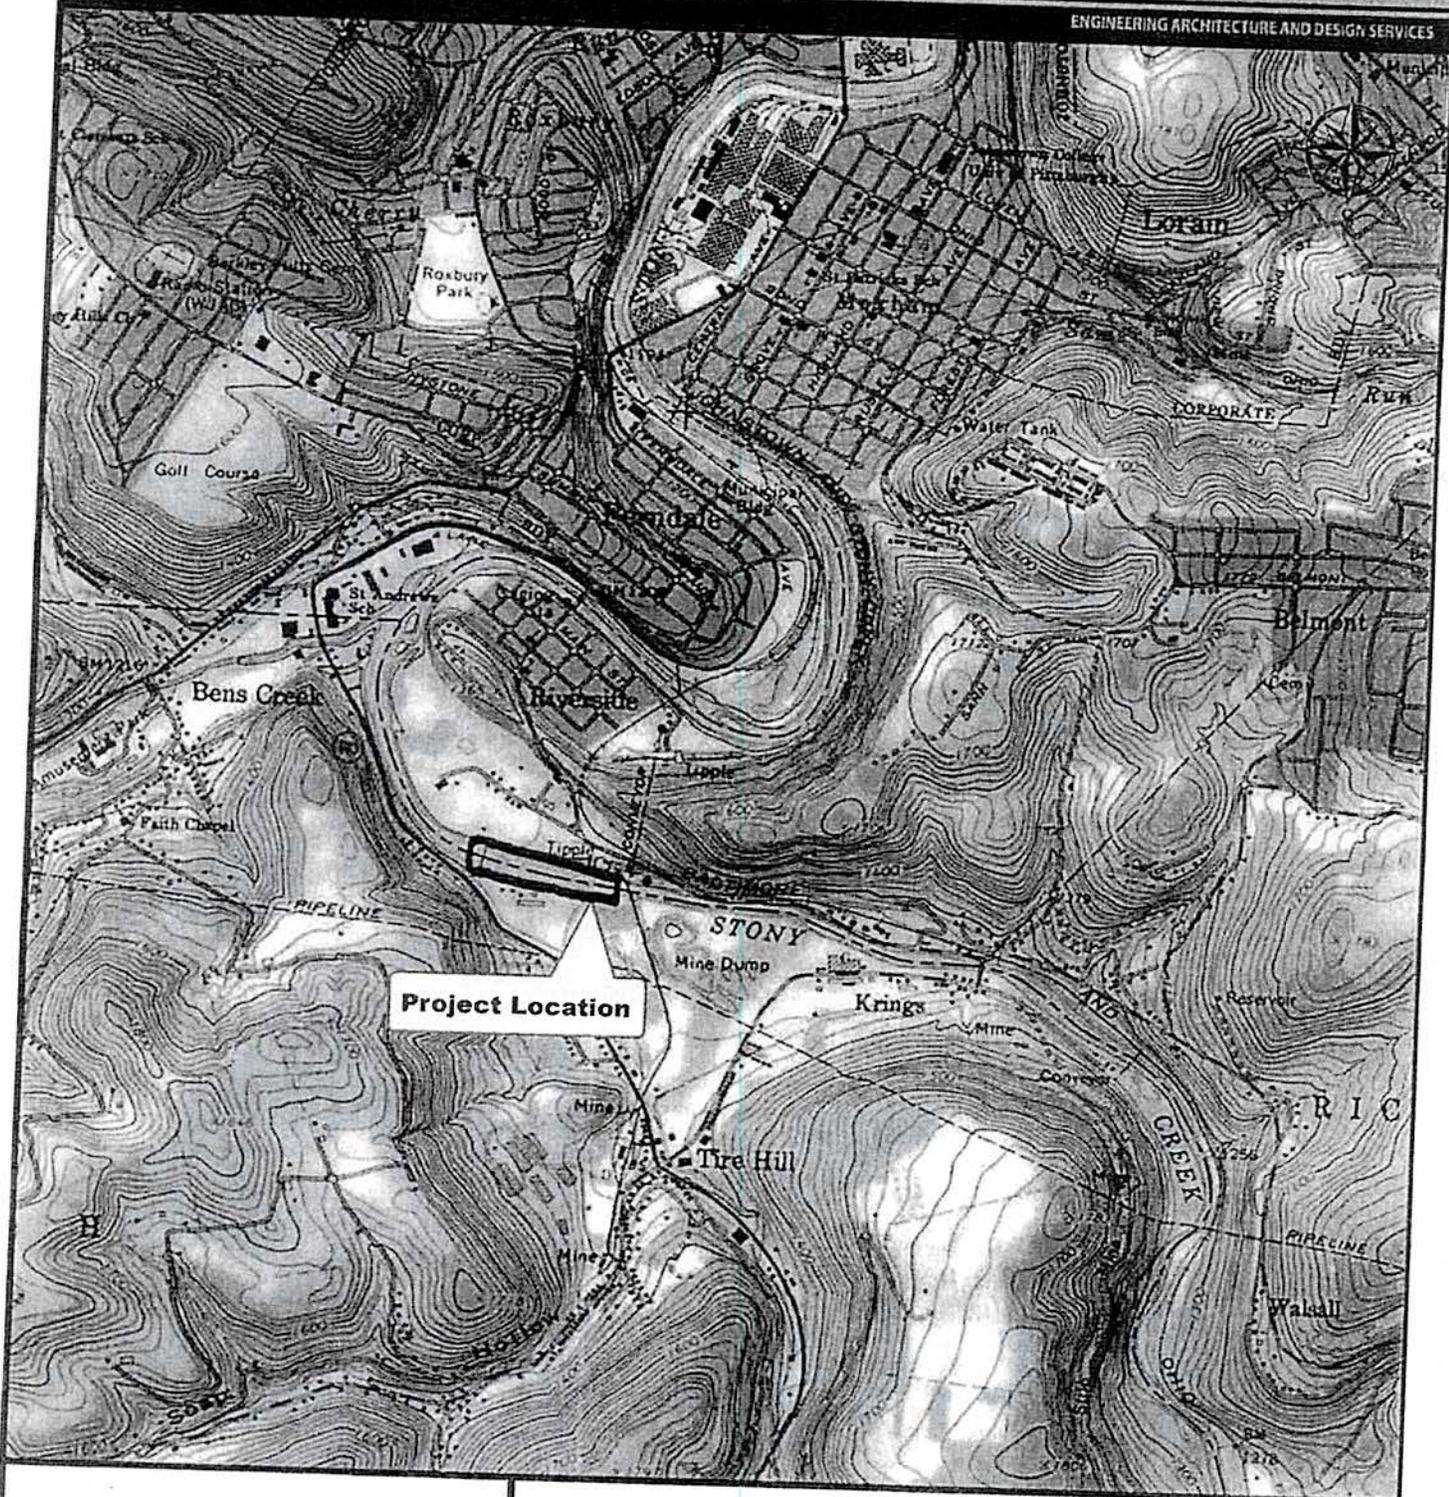

Scale  
 1 Inch = 2,000 feet  
 North American Datum of 1983  
 Date: 2/29/2013

**Whitewater Park  
 Location Map**  
 Johnstown, PA USGS Quadrangle



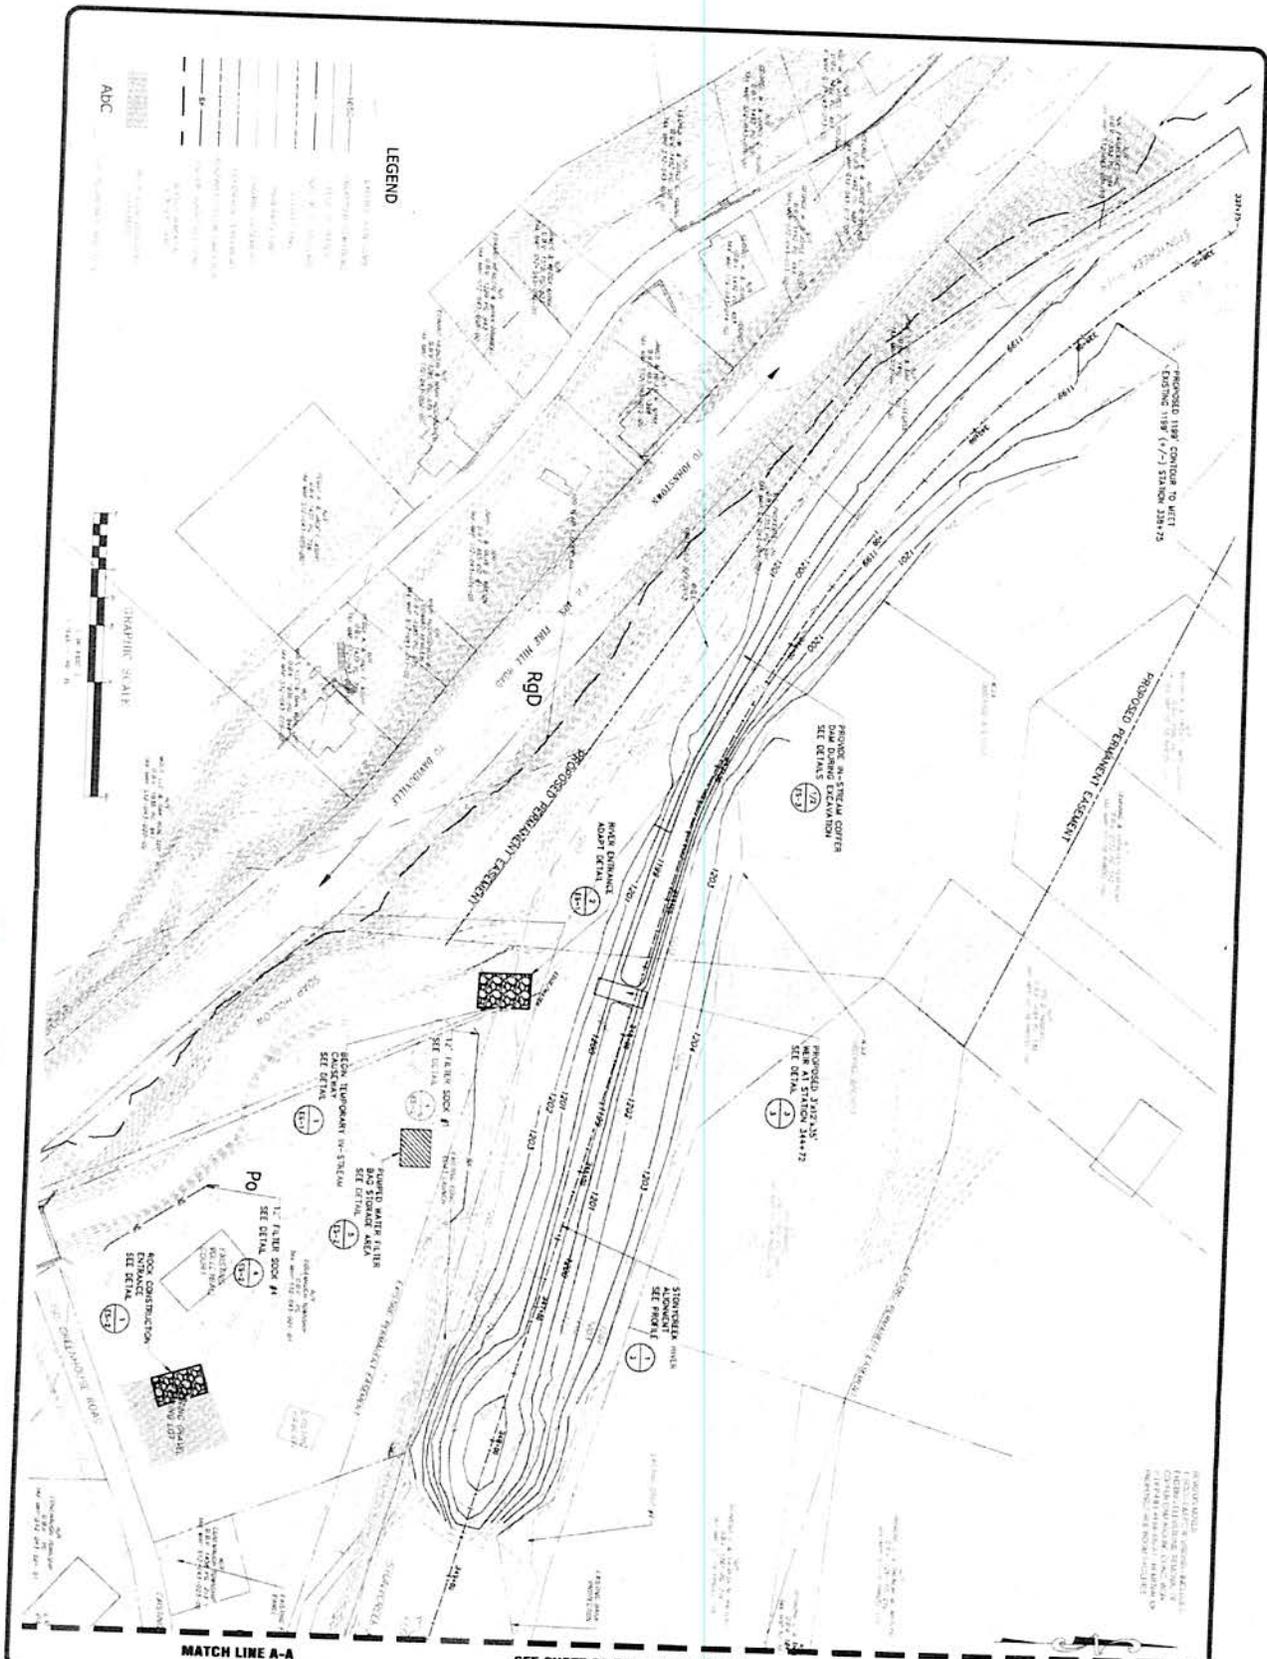

Phase II work

DRAWING NO.  
**2**

**CONEMAUGH TOWNSHIP**  
**CONTRACT NO. 2013-G-01**  
**STONYCREEK WHITEWATER PARK**  
**PHASE II**  
 SITE PLAN AND EROSION AND SEDIMENTATION CONTROL PLAN

**EADG GROUP**  
 450 ABERDEEN DRIVE  
 SOMERSET, PA. 15501  
 PHONE: 814-443-8551  
 FAX: 814-443-2748  
 www.eadsgroup.com

No.	Revisions	Date
1	ISSUE	02/06/2014
2	REV. P.L. #26-335A	07/26/2014


Date: 1/14/2014  
 Drawn by: VJP  
 Checked by:  
 Project No.: 2013-13-023  
 File No.: 2013-13-023

Scale


MATCH LINE A-A

SEE SHEET 2A FOR CONTINUATION

MATCH LINE A-A

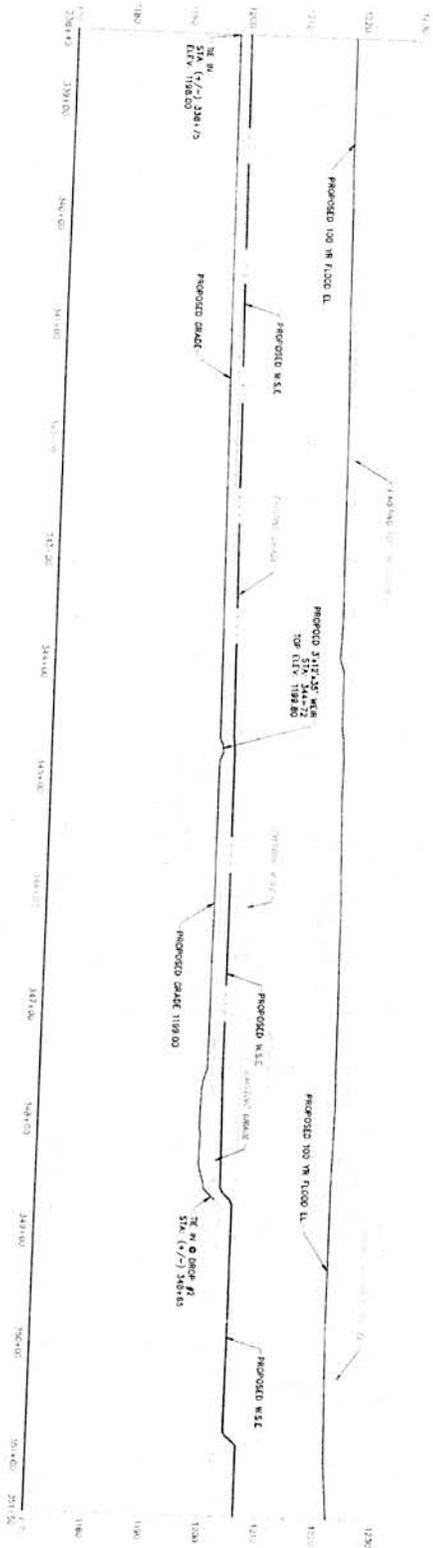

PROFILE  
SCALE: 1"=10' HORIZ  
3  
STA. 239+00 TO STA. 250+00

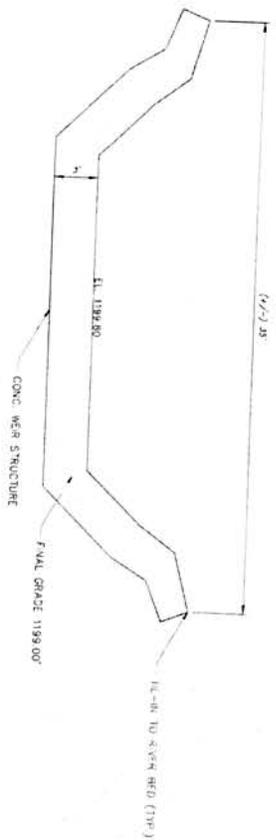

WEIR ELEVATION  
SCALE: 1"=10' HORIZ  
3  
VERT. 1"=8'



WEIR SECTION  
SCALE: 1"=5'  
3  
WEIR LENGTH: 35'

CONEMAUGH TOWNSHIP  
CONTRACT NO. 2013-G-01  
STONYCREEK WHITWATER PARK  
PHASE II  
PROFILE & WEIR CROSS SECTIONS

**EADS GROUP**  
CONSULTING ENGINEERS  
450 ABERDEEN DRIVE  
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Revised	No.	Revisions	Date
AS NOTED			
Date			
Drawn By			
Checked By			
Project No.			
Sheet No.			
File No.			

Seal  
Date

Drawing No.  
3